

SECTION J COMPLIANCE NOTE

THESE PLANS TO BE READ IN CONJUNCTION WITH ASSOCIATED SECTION J REPORT.

BUILDING FABRIC

- REFER SECTION J REPORT FOR ALL REQUIRED MINIMUM ROOF, WALL, CEILING, FLOOR, WINDOW & DOOR INSULATION VALUES. - RECESSED LIGHTING TO BE "IC" RATED TO ALLOW CEILING INSULATION TO GO OVER THE FITTING WITH NO PENETRATION

BUILDING SEALING

- EXHAUST FANS TO BE FITTED WITH SELF-CLOSING DAMPER. - EXTERNAL DOORS & WINDOWS TO BE FITTED WITH AIR INFILTRATION SEALS. - ENTRY DOORS TO BE FITTED WITH SELF-CLOSING

AIR CONDITIONING AND VENTILATION - PROVIDE TIME SWITCH TO AIR CONDITIONING

ARTIFICIAL LIGHTING AND POWER - INTERIOR LIGHTING TO BE SWITCHED WITHIN THE LIGHTING ZONE. - INTERIOR DECORATIVE AND DISPLAY LIGHTING TO BE

CONTROLLED SEPERATELY FROM OTHER LIGHTING & WITH A TIME SWITCH IF > 1kW. - EXTERIOR LIGHTING TO BE ON DAYLIGHT SENSORS. - MAX. ILLUMINATION POWER - REFER TO SECTION J - PROVIDE TIME SWITCH TO BOILING & CHILLED WATER STORAGE UNITS.

HEATED WATER SUPPLY - DESIGNED AND INSTALLED IN ACCORDANCE WITH

PART B2 OF NCC VOL. 3

- ELECTRICITY AND GAS SUPPLY TO BE ON TIME-OF-USE METERS FACILITIES FOR SOLAR PHOTOVOLTAIC AND BATTERY

FACILITIES FOR ENERGY MONITORING

- MAIN FLECTRIC SWITCHBOARD: a) TO BE FITTED WITH AT LEAST 2 EMPTY THREE-PHASE CIRCUIT BREAKER SLOTS AND 2 4 DIN RAIL SPACERS LABELLED FOR EACH SOLAR PV SYSTEM AND FACH BATTERY SYSTEM b) TO BE SIZED TO ACCOMODATE THE INSTALLATION OF

SOLAR PV SYSTEM PRODUCING THEIR MAXIMUM ELECTRICAL OUTPUT ON AT LEAST 20% OF BUILDING **ROOF AREA** - AT LEAST 20% OF ROOF AREA TO BE LEFT CLEAR FOR FUTURE INSTALLATION OF SOLAR PANELS

ACCESSIBILITY NOTE

BUILDING CONTRACTOR TO ENSURE ALL ACCESSIBLE FACILITIES, CIRCULATION SPACES AND PATHS OF TRAVEL ARE TO COMPLY WITH BCA VOL. 1 AND AS 1428.1 AND ALL TACTILE GROUND SURFACE INDICATORS ARE TO COMPLY WITH BCA VOL. 1 D4D9, *AS 1428.1* AND *AS 1428.4.1*.

STAIR, BARRIER & HANDRAIL NOTE

TAIRS TO BE CONSTRUCTED IN ACCORDANCE WITH THE RELEVANT PARTS OF BCA VOL. 1. D3D14 GOINGS AND RISERS AND AS1428.1 DESIGN FOR ACCESS AND MOBILITY, PART 11 STAIRWAYS. BARRIERS TO BE CONSTRUCTED IN ACCORDANCE WITH

BCA VOL. 1, D3D17-D3D21. HANDRAILS TO BE CONSTRUCTED IN ACCORDANCE WITH BCA VOL. 1, D3D22 HANDRAILS & AS1428.1, PARTS 10 -

GOINGS - UNLESS NOTED OTHERWISE - 280 RISERS - 115 MIN. 190 MAX. BUILDING CONTRACTOR TO CHECK FINISHED LEVELS ON SITE TO ENSURE ALL RISERS ARE EQUAL

RAMPS & LANDINGS NOTE

RAMPS & LANDINGS TO BE CONSTRUCTED IN ACCORDANCE WITH AS 1428.1 DESIGN FOR ACCESS AND MOBILITY, PART 10 WALKWAYS, RAMPS AND LANDINGS.

SEWER & STORMWATER NOTE

PLUMBING AND DRAINAGE DESIGN & INSTALLATION TO BE IN ACCORDANCE WITH NCC PLUMBING CODE OF AUSTRALIA AND AS/NZS 3500 PLUMBING AND DRAINAGE PARTS 0,1,2,3 & 4.

PLUMBING CONTRACTOR SHALL ENSURE THE DESIGN AND INSTALLATION IS IN COMPLIANCE WITH THE ABOVE AND SHALL LOCATE ALL BOUNDARY RISERS & MAINS SPURS PRIOR TO COMMENCEMENT OF WORK. CONNECT NEW SEWER & STORMWATER PIPE SYSTEM TO EXISTING COUNCIL MAINS SYSTEM. OR CONNECT TO NEW OR EXISTING ON-SITE SEWER

CUT & FILL NOTE: ALL CUT & FILL LEVELS TO BE CHECKED ON SITE BY BUILDING CONTRACTOR PRIOR TO EXCAVATION.

ON-STREET CARPARKING NOTE

2890.5 ON-STREET CAR PARKING.

TREATMENT SYSTEM.

BUILDING CONTRACTOR TO ENSURE NEW ACCESSIBLE AND SHARED SPACES COMPLY WITH WITH AS/NZS

COMPLIANCE NOTES

BUILDING CLASS: CLASS 9b - CHILDCARE CENTRE CONSTUCTION TYPE:

(<2000m²/12000m³)

BCA VOLUME 1 STATE VARIATIONS REFER TO STATE VARIATIONS WHERE RELEVANT.

SECTION A GOVERNING REQUIREMENTS BUILDING DESIGN & COMPLICANCE, CONSTRUCTION AND MATERIAL SELECTIONS TO COMPLY WITH THIS PART INCLUDING STATE VARIATIONS AND REFERENCED AUSTRALIAN STANDARDS. THE CONTRACTOR AND ALL SUB-CONTRACTORS SHALL REFERENCE THESE DOCUMENTS FOR FURTHER DETAILS TO ENSURE DESIGN AND INSTALLATION COMPLIANCE. CONTRACTORS TO ENSURE MATERIALS USED ARE SUITABLE FOR PURPOSE,

ARE MANUFACTURED TO AUSTRALIAN STANDARDS, HAVE THE REQUIRED CERTIFICATION AND FIRE HAZARD PROPERTIES. SECTION B STRUCTURAL PROVISIONS STRUCTURE TO COMPLY WITH PART B1 STRUCTURAL

AND SPECIFICATIONS.

SECTION C FIRE RESISTANCE THE BUILDING DESIGN COMPLIES WITH APPLICABLE PARTS OF SECTION C FOR THE BUILDING CLASS, CONSTRUCTION TYPE, AREA & VOLUME. SPECIFICATION 7 FIRE HAZARD PROPERTIES: BUILDING ELEMENTS, MATERIALS AND FINISHES TO BE SELECTED IN ACCORDANCE WITH SPECIFICATION 7 FIRE HAZARD PROPERTIES. PROVIDE WRITTEN EVIDENCE TO

PROVISIONS, REFER STRUCTURAL ENGINEER'S PLANS

SECTION D ACCESS AND EGRESS THE DESIGN OF ACCESS TO AND WITHIN THE BUILDING HAS BEEN DESIGNED TO COMPLY WITH THE RELEVANT PARTS OF SECTION D.

PRINCIPAL CERTIFYING AUTHORITY.

PART D2 PROVISION FOR ESCAPE - NUMBER OF EXITS REQUIRED, EXIT TRAVEL DISTANCES, DISTANCES BETWEEN ALTERNATIVE EXITS AND DIMENSIONS OF EXITS AND PATHS OF TRAVEL AND NUMBER OF

BE SELECTED & LOCATED BY AN APPROPRIATELY

ACCREDITED PERSON & IN ACCORDANCE WITH THIS

PART (INCLUDING RELEVANT STATE VARIATIONS) AND

2444 PORTABLE FIRE EXTINGUISHERS AND FIRE

& FIRE DETECTION & WARNING SYSTEMS, WHERE

REQUIRED, TO BE DESIGNED & INSTALLED BY AN

LIGHTING AND EXIT SIGNS FOR BUILDINGS AND AS

1670.1 FIRE DETECTION, WARNING, CONTROL AND

APPROPRIATELY ACCREDITED PERSON & IN

AND COMMISSIONING - FIRE.

THE RELEVANT F4D4 TABLE.

MOBILITY.

SECTION F HEALTH AND AMENITY

BLANKETS - SELECTION AND LOCATION.

AS 2441 INSTALLATION OF FIRE HOSE REELS AND AS

PART E4 VISIBILITY IN EMERGENCY, EXIT SIGNS AND

WARNING SYSTEMS: EMERGENCY LIGHTING, EXIT SIGNS

ACCORDANCE WITH THIS PART, AS 2293.1 EMERGENCY

INTERCOM SYSTEMS - SYSTEM DESIGN, INSTALLATION

THE BUILDING HAS BEEN DESIGNED TO COMPLY WITH

THE RELEVANT PARTS OF THIS SECTION INCLUDING:

PART F4 SANITARY AND OTHER FACILITIES: SANITARY

PARTS F4D5, F4D6 AND F4D7: ACCESSIBLE SANITARY

COMPARTMENTS AND ACCESSIBLE UNISEX SHOWERS

HAVE BEEN DESIGNED IN ACCORDANCE WITH THESE

PARTS AND AS 1428.1 DESIGN FOR ACCESS &

PART F6 LIGHT AND VENTILATION: REFER STATE VARIATION NSW F6D6 - MECHANICAL AIRCONDITIONING SYSTEM TO COMPLY WITH AS 1668.2 THE USE OF

VENTILATION AND AIR CONDITIONING IN BUILDINGS

PART 2 MECHANICAL VENTILATION IN BUILDINGS.

COMPLY WITH RELEVANT PARTS OF THIS SECTION.

REFER TO ENERGY ASSESSOR'S SECTION J REPORT AND

THESE PLANS FOR DETAILS AND SPECIFICATIONS FOR

COMPLIANCE WITH THE RELEVANT PARTS OF SECTION J.

SECTION G ANCILLARY PROVISIONS

H SPECIAL USE BUILDINGS

FACILITIES, ACCESSIBLE UNISEX SANITARY

FACILITIES HAVE BEEN PROVIDED IN ACCORDANCE WITH

PART F2 WET AREAS AND OVERFLOW PROTECTION,

AND AS 3740 WATERPROOFING OF DOMESTIC WET

STEEL: MATERIALS, CONSTRUCTION, FABRICATION PERSONS ACCOMMODATED COMPLY WITH THESE AND ERECTION: TO AS 4100 STEEL STRUCTURES. PART D3 CONSTRUCTION OF EXITS - EXITS MASONRY: MATERIALS AND CONSTRUCTION TO AS CONSTRUCTION, HARDWARE AND SIGNAGE COMPLY

WITH THIS PART. 3700 MASONRY STRUCTURES. PART D4 ACCESS FOR PEOPLE WITH A DISABILITY COLD-FORMED STEEL: AS/NZS 4600 COLD-FORMED ACCESS TO AND THROUGHOUT THE BUILDING AND STEEL STRUCTURES. FACILITIES COMPLY WITH THIS PART AND AS 1428 DESIGN FOR ACCESS & MOBILITY, PART 1: GENERAL

PLUMBING AND DRAINAGE: DESIGN & INSTALLATION REQUIREMENTS FOR ACCESS - NEW BUILDING WORK TO AS/NZS 3500.0, AS/NZS 3500.1, AS/NZS 3500.2, AND PART 4.1:MEANS TO ASSIST THE ORIENTATION OF AS/NZS 3500.3 AND AS/NZS 3500.4 AND THE PEOPLE WITH VISION IMPAIRMENT - TACTILE GROUND PLUMBING CODE OF AUSTRALIA. SURFACE INDICATORS. CONTRACTOR TO ENSURE ALL ACCESSIBLE FACILITIES,

GAS: TO AS/NZS 5601.1 GENERAL INSTALLATIONS. CIRCULATION SPACES, PATHS OF TRAVEL, DOOR **ELECTRICAL:** TO *AS/NZS 3000 ELECTRICAL* HARDWARE AND TACTILE GROUND SURFACE INDICATORS ARE INSTALLED TO COMPLY. INSTALLATIONS UNLESS OTHERWISE DOCUMENTED. SECTION E SERVICES AND EQUIPMENT ELECTRICAL SYSTEMS TO AS/NZS 3008.1.1 PART E1 FIRE FIGHTING EQUIPMENT: WHERE REQUIRED, ELECTRICAL INSTALLATIONS AND SAA HB 301. FIRE HOSE REELS & PORTABLE FIRE EXTINGUISHERS TO

TELECOMMUNICATIONS SYSTEMS: TO AS/ACIF S008, AS/ACIF S009, AS/NZS 3080, SAA HB 243 AND SAA HB 29.

GLAZING: SELECTION AND INSTALLATION TO AS 2047 WINDOWS AND EXTERNAL GLAZED DOORS IN BUILDINGS AND GLASS TYPE AND THICKNESS TO AS 1288 GLASS IN BUILDINGS - SELECTION AND INSTALLATION. ALL OTHER COMPONENTS TO COMPLY WITH RELEVANT STANDARDS.

BEFORE

YOU DIG www.byda.com.au ALL UNDERGROUND SERVICES, PIPES AND

CABLES TO BE LOCATED PRIOR TO

EXCAVATION. GO TO www.byda.com.au.

AMBIGUITY, ERROR OR OMISSION NOTE **BUILDING NOTES:**

ALL DIMENSIONS TO BE CHECKED ON SITE PRIOR TO

COMMENCEMENT OF WORKS. WRITTEN DIMENSIONS

TAKE PRECEDENCE OVER SCALING. IF IN DOUBT, ASK.

BUILDER TO ENSURE ALL UNDERGROUND SERVICES,

EXCAVATION. GO TO www.byda.com.au FOR SERVICES

PIPES AND CABLES TO BE LOCATED PRIOR TO

SITE: THE BUILDER SHALL SUPPLY/INSTALL AND

LOCAL AUTHORITY REQUIREMENTS:

- SEDIMENT CONTROL MEASURES

STABILISED ENTRY POINT

TOILET FACILITIES

BY THE NEW WORK.

ENGINEER'S DETAILS.

TIMBER FRAMING CODE.

CONTROLLED RUBBISH AREA

MAINTAIN THE FOLLOWING IN ACCORDANCE WITH

COMPLIANCE: ALL BUILDING WORK TO COMPLY WITH

REFERENCED `AUSTRALIAN STANDARDS AND LOCAL

COUNCIL AUTHORITY REQUIREMENTS. ALL AREAS TO

BE MADE GOOD BY THE BUILDER WHERE DISTURBED

NCC SECTION J: ALL SELECTIONS TO COMPLY WITH

ENERGY EFFICIENCY PERFORMANCE REQUIREMENTS

CONCRETE: MATERIALS AND CONSTRUCTION: TO *AS*

SPECIFICATION AND SUPPLY OF CONCRETE: TO *AS*

CONCRETE FOOTINGS, SLABS AND REINFORCEMENT

TIMBER FRAMING: FABRICATION AND INSTALLATION

OF TIMBER CONSTRUCTION TO COMPLY WITH AS 1684

1379 SPECIFICATION AND SUPPLY OF CONCRETE.

TO BE IN ACCORDANCE WITH STRUCTURAL

OF THE ASSOCIATED SECTION J REPORT.

3600 CONCRETE STRUCTURES.

THE 'BUILDING CODE OF AUSTRALIA', AND ANY

INFORMATION.

I 'IF IN DOUBT, ASK: IF IT DOESN'T LOOK RIGHT, QUESTION IT

ANY PERSON INVOLVED WITH THIS PROJECT (CONSULTANT, CONTRACTOR, SUB-CONTRACTOR, AUTHORITY, SUPPLIER, OWNER AND THE LIKE) THAT DISCOVERS ANY AMBIGUITY. ERROR OR OMISSION IN I ICONO'S DOCUMENTS, OR BETWEEN ICONO'S DOCUMENTS AND ANY OTHER RELEVANT DOCUMENTS (CONSULTANT'S PLANS, REPORTS, DCP, LEP, BCA, AUSTRALIAN STANDARDS OR THE LIKE), SHALL ADVISE ICONO IMMEDIATELY AND SEEK CLARIFICATION. NO DECISIONS WITH REGARD TO APPROVAL, PRICING, SUPPLY OR CONSTRUCTION ARE TO BE MADE WITH RESPECT TO THE ISSUE WITHOUT WRITTEN APPROVAL OR UPDATED DOCUMENTATION TO CORRECT THIS AMBIGUITY, ERROR OR OMISSION.

WORKPLACE HEALTH & SAFETY

DURING CONSTRUCTION AND THE ON GOING MAINTENANCE OF THIS BUILDING ENSURE WORKPLACE HEALTH AND SAFETY IS FULLY UNDERSTOOD AND IMPLEMENTED BY ALL PERSONS INVOLVED WITH THIS

REFER TO THE PRELIMINARIES WORKSECTION IN THE SPECIFICATION FOR THE EXPLANATIONS OF THE 10 KEY AREAS OF INFLUENCE. THESE AREAS ARE AS FOLLOWED;

- FALLS, SLIPS AND TRIPS. - FALLING OBJECTS, - TRAFFIC MANAGEMENT,

- SERVICES, - MANUAL TASKS, - HAZARDOUS SUBSTANCES. - CONFINED SPACES, - PUBLIC ACCESS.

- OPERATION USE OF BUILDING RESIDENTIAL

- OTHER HIGH RISK ACTIVITY.

BUILDINGS,

ISSUED FOR DA 31/10/2024 PROGRESS ISSUE 28/10/2024 PROGRESS ISSUE 23/11/2023 PROGRESS ISSUE 8/11/2023





bdaa

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Shop 30 Kooringal Mall

Wagga Wagga, NSW, 2650

Issue / Amendment No.

Lake Albert Road

PO Box 8834


PROPOSED ALTERATIONS AND ADDTIONS **TUMUT COMMUNITY PRESCHOOL** LOT 1, DP 828879 50 HOWICK STREET, TUMUT


TUMUT COMMUNITY PRESCHOOL


SITE / SITE ANALYSIS PLAN 22-37 ΑU AS SHOWN AT A1 ICONO


PRELIMINARY NOT FOR CONSTRUCTION

SCALE 1:200 A1 SIZE SCALE 1:400 A3 SIZE

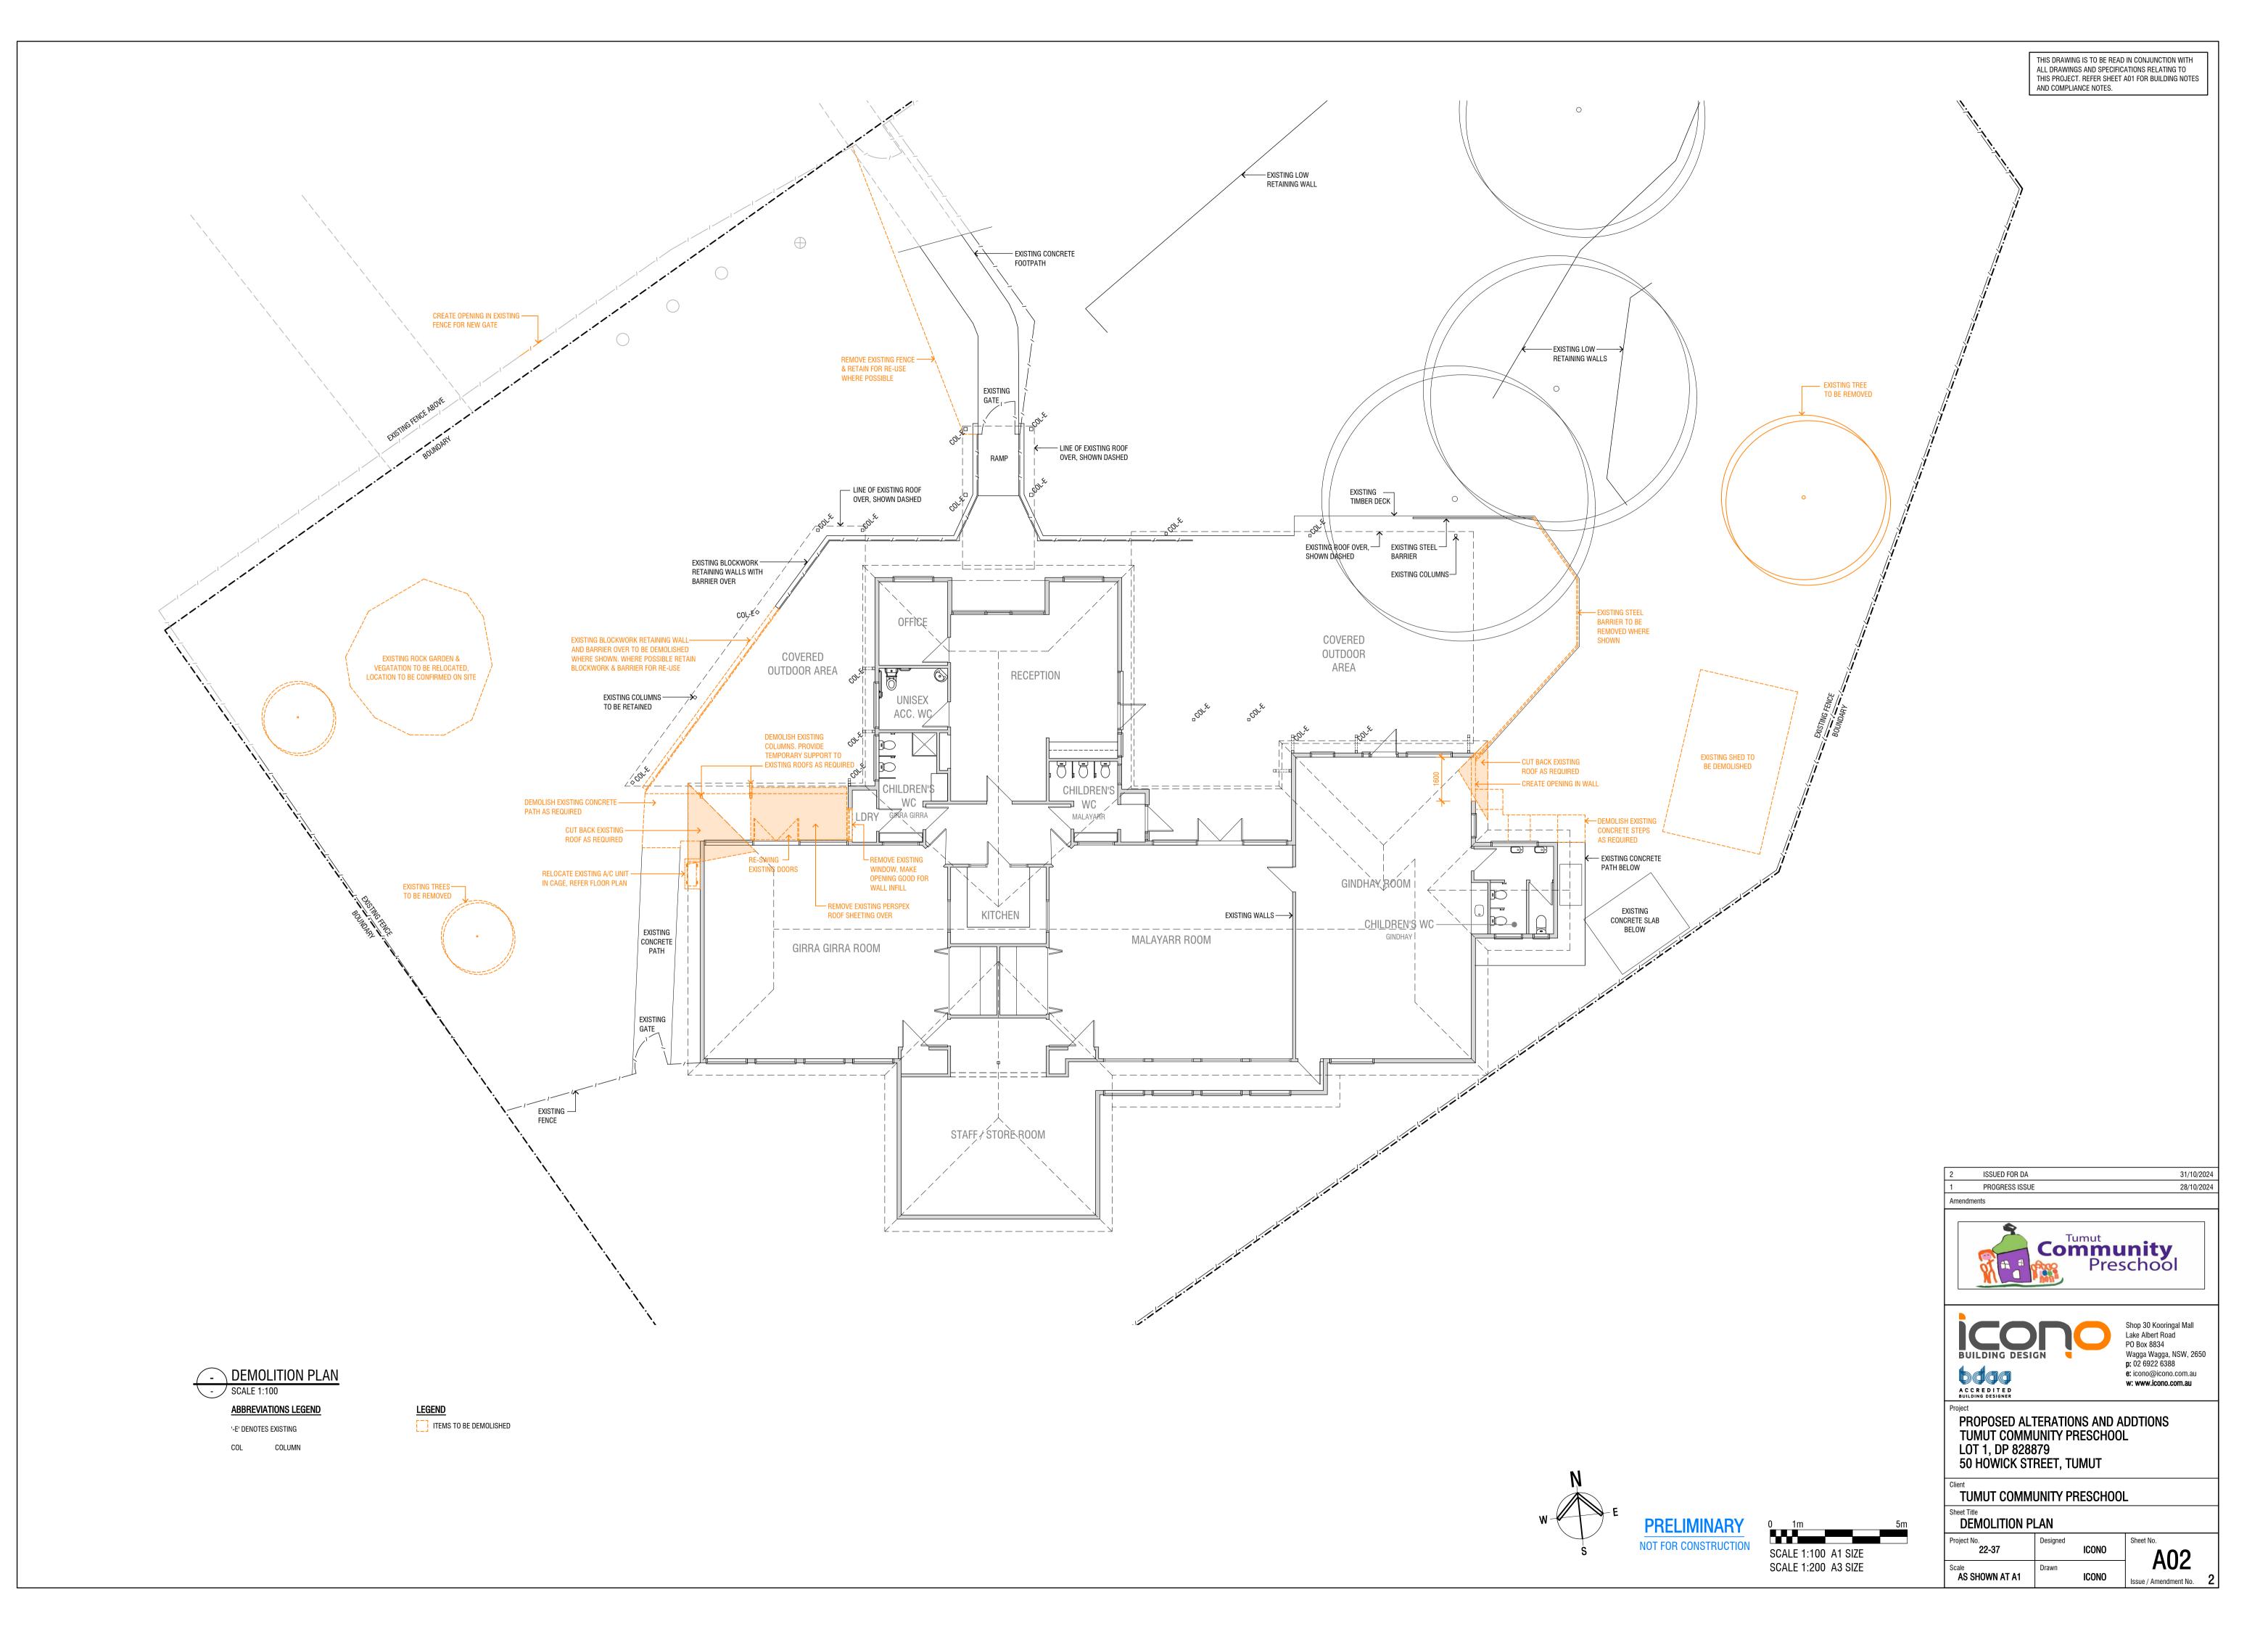

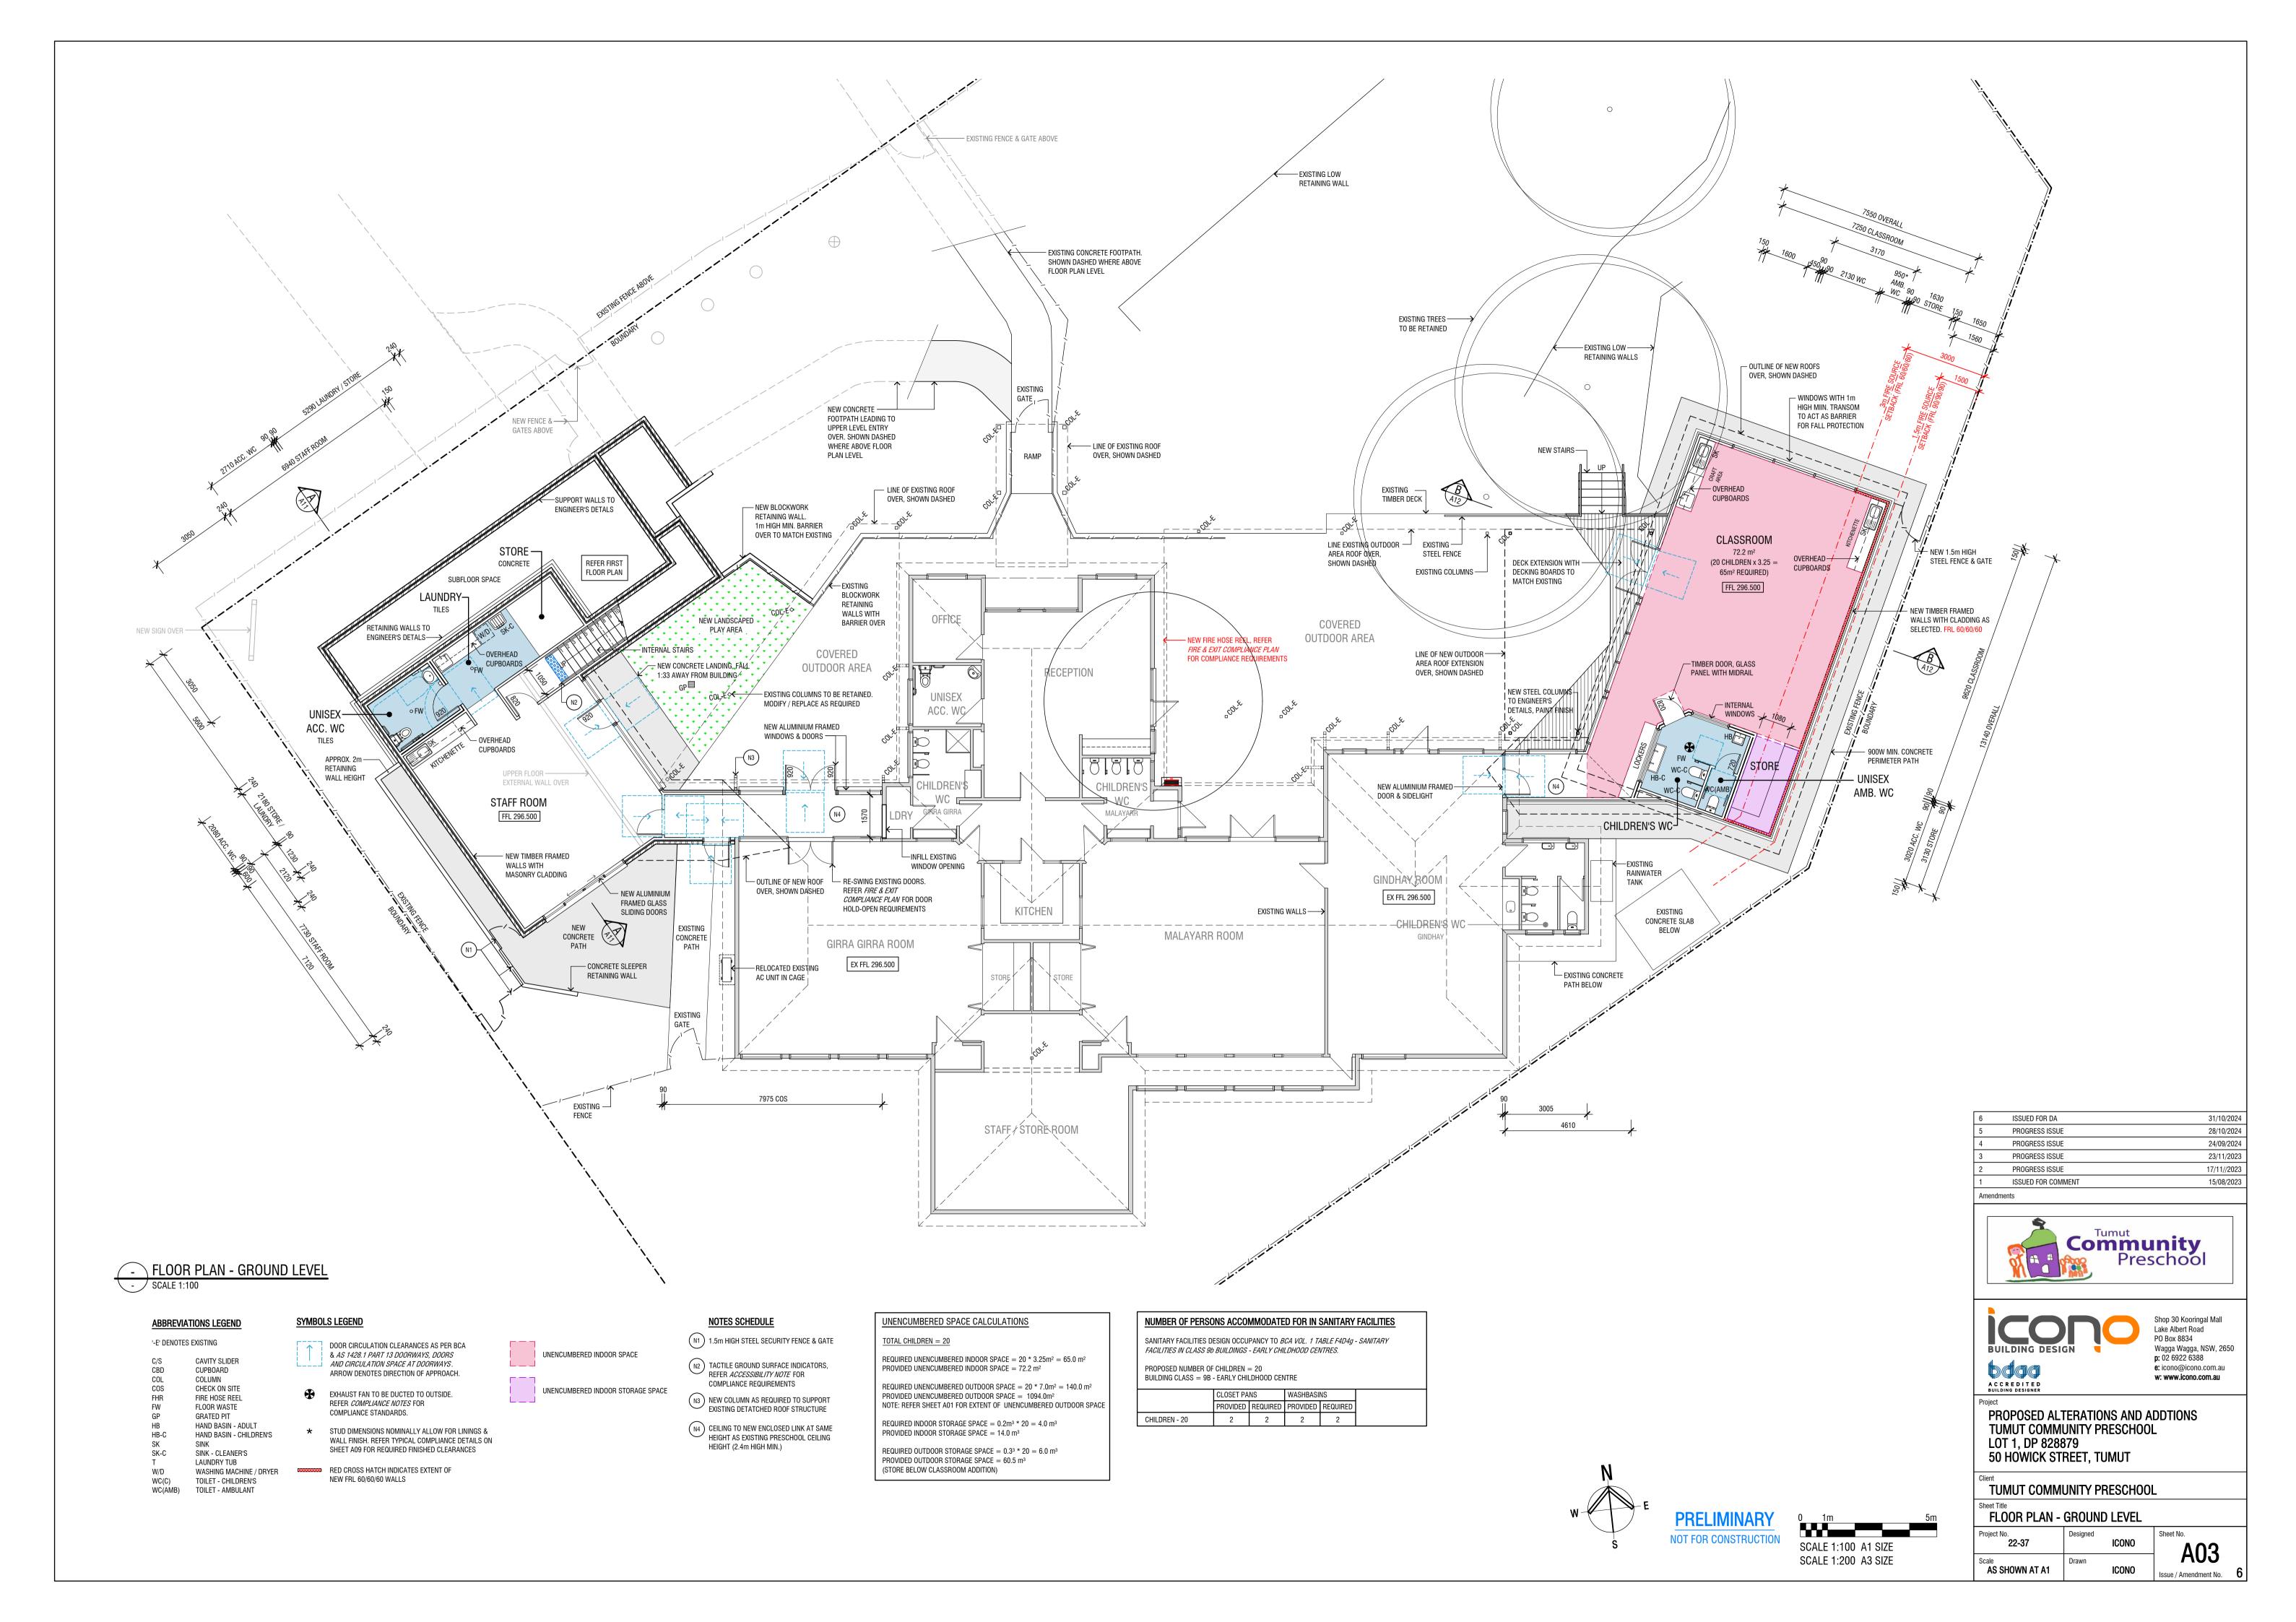

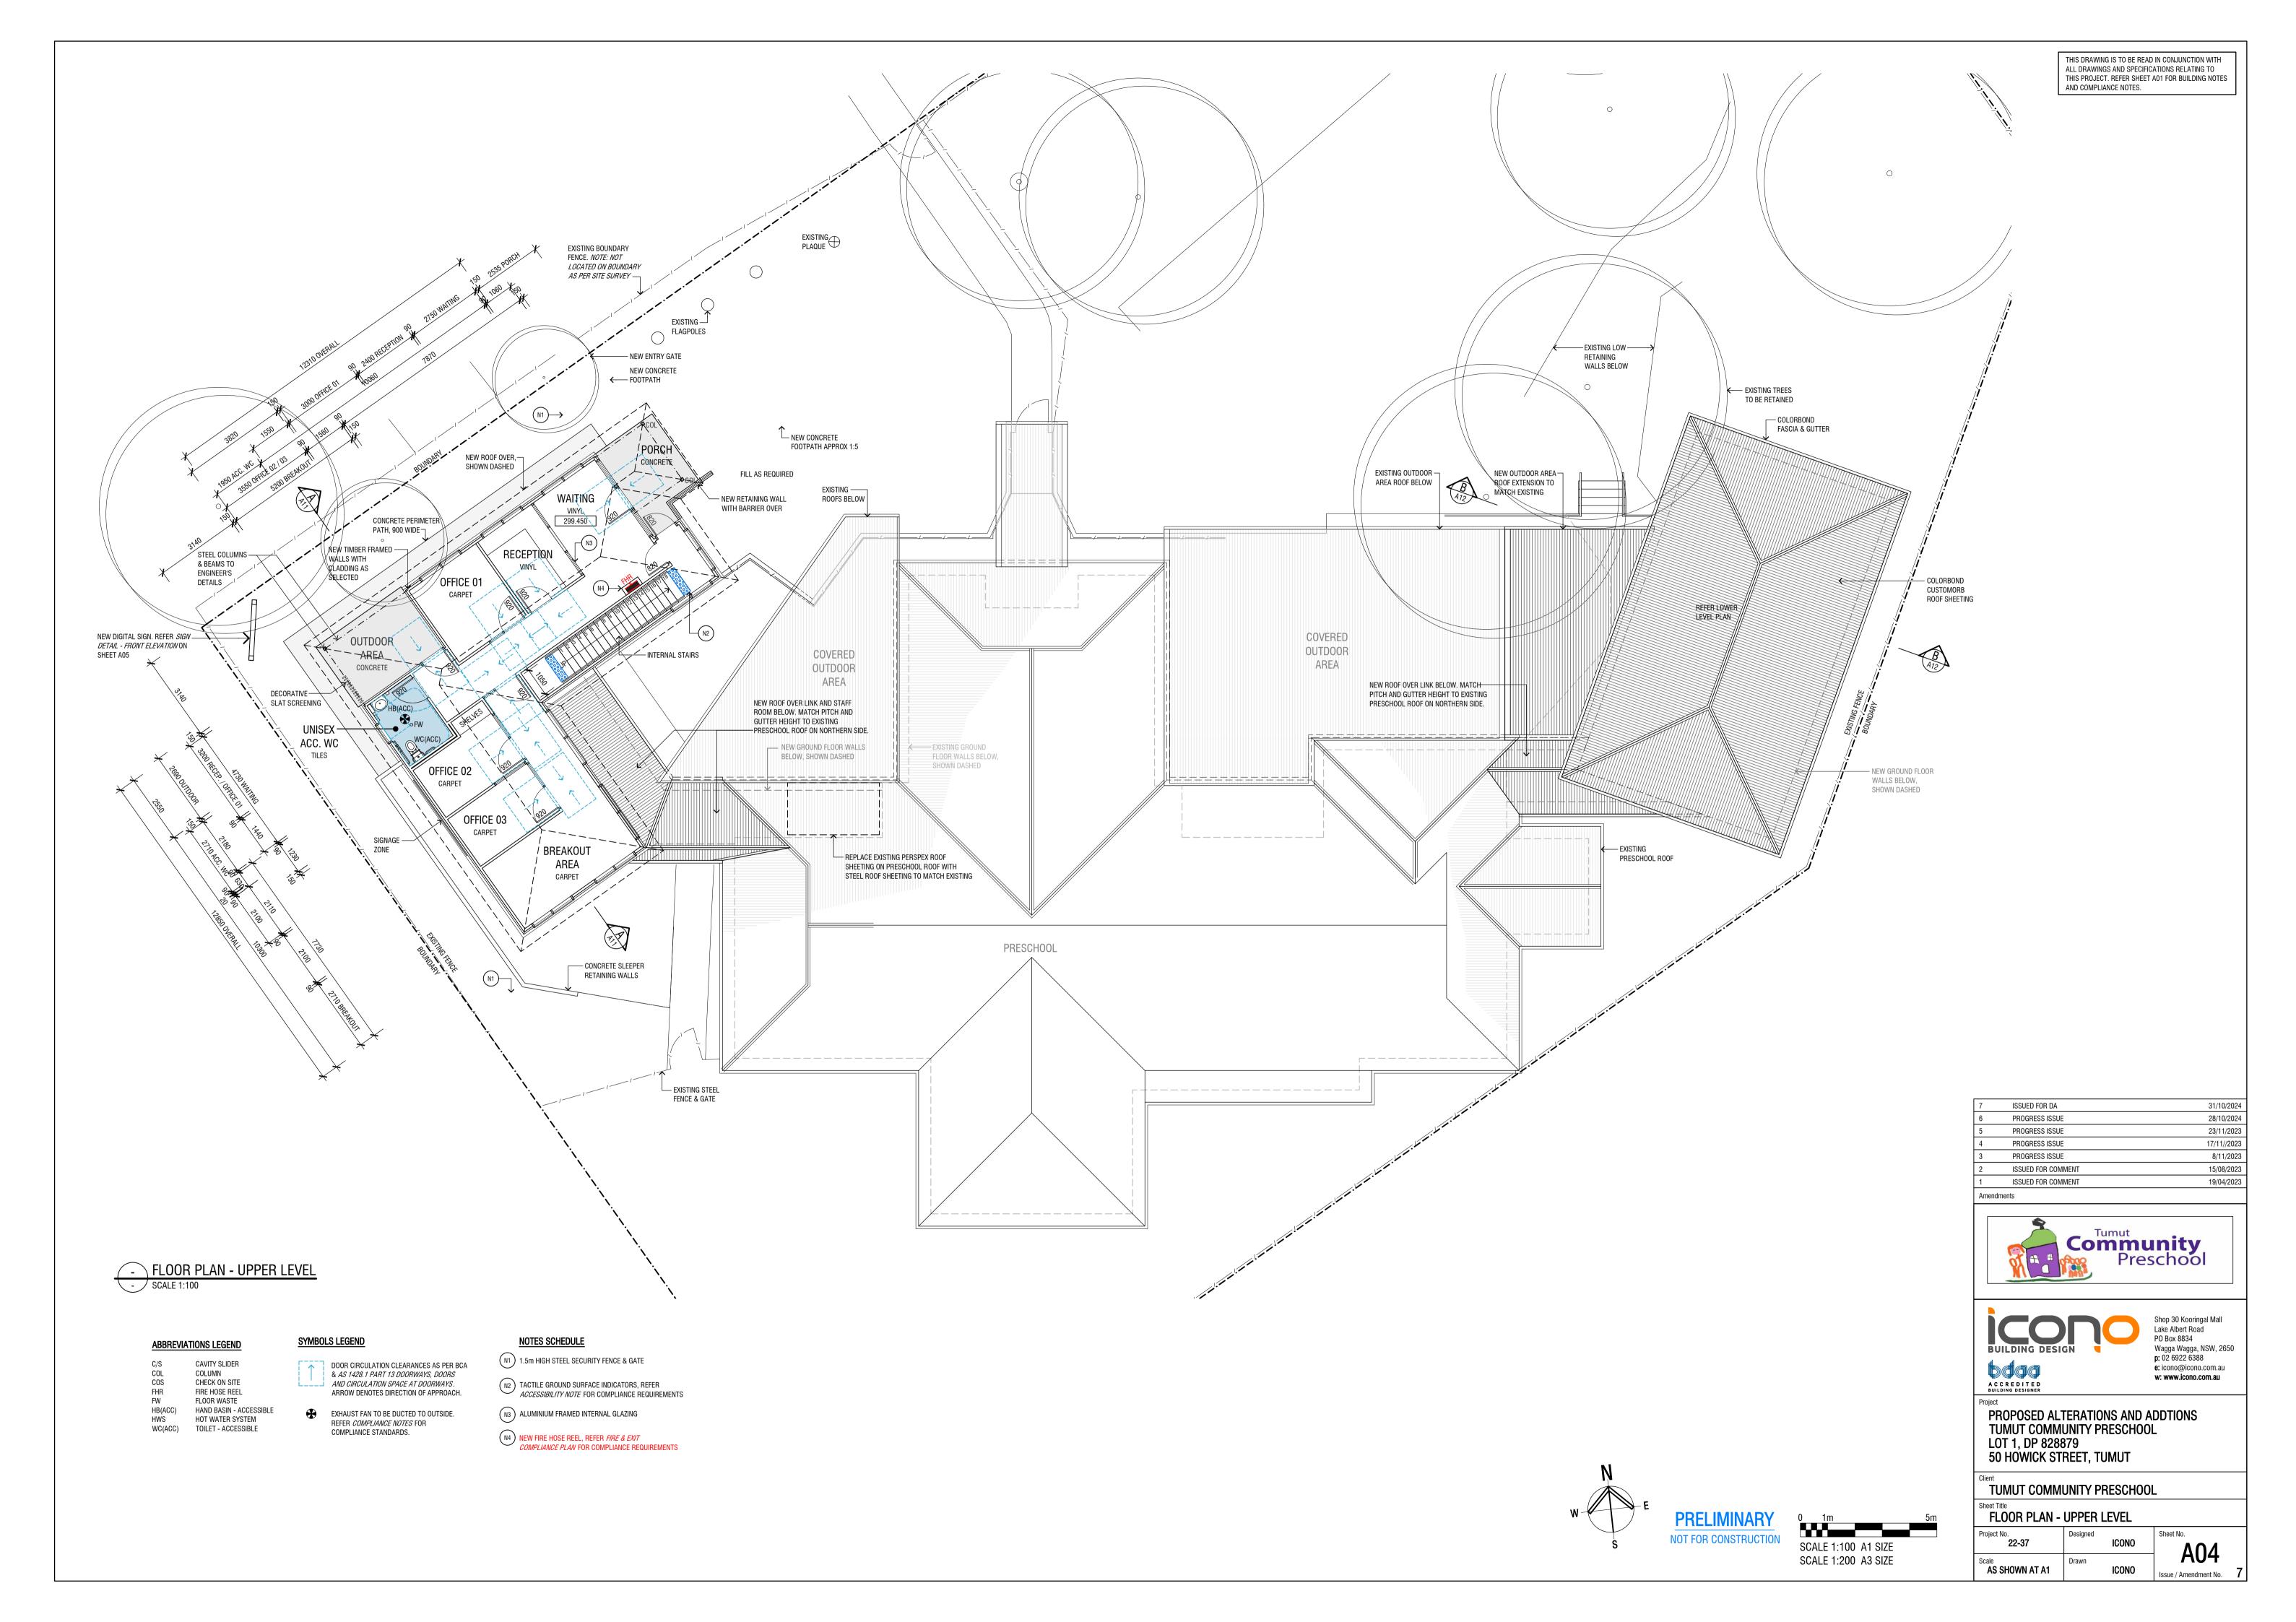

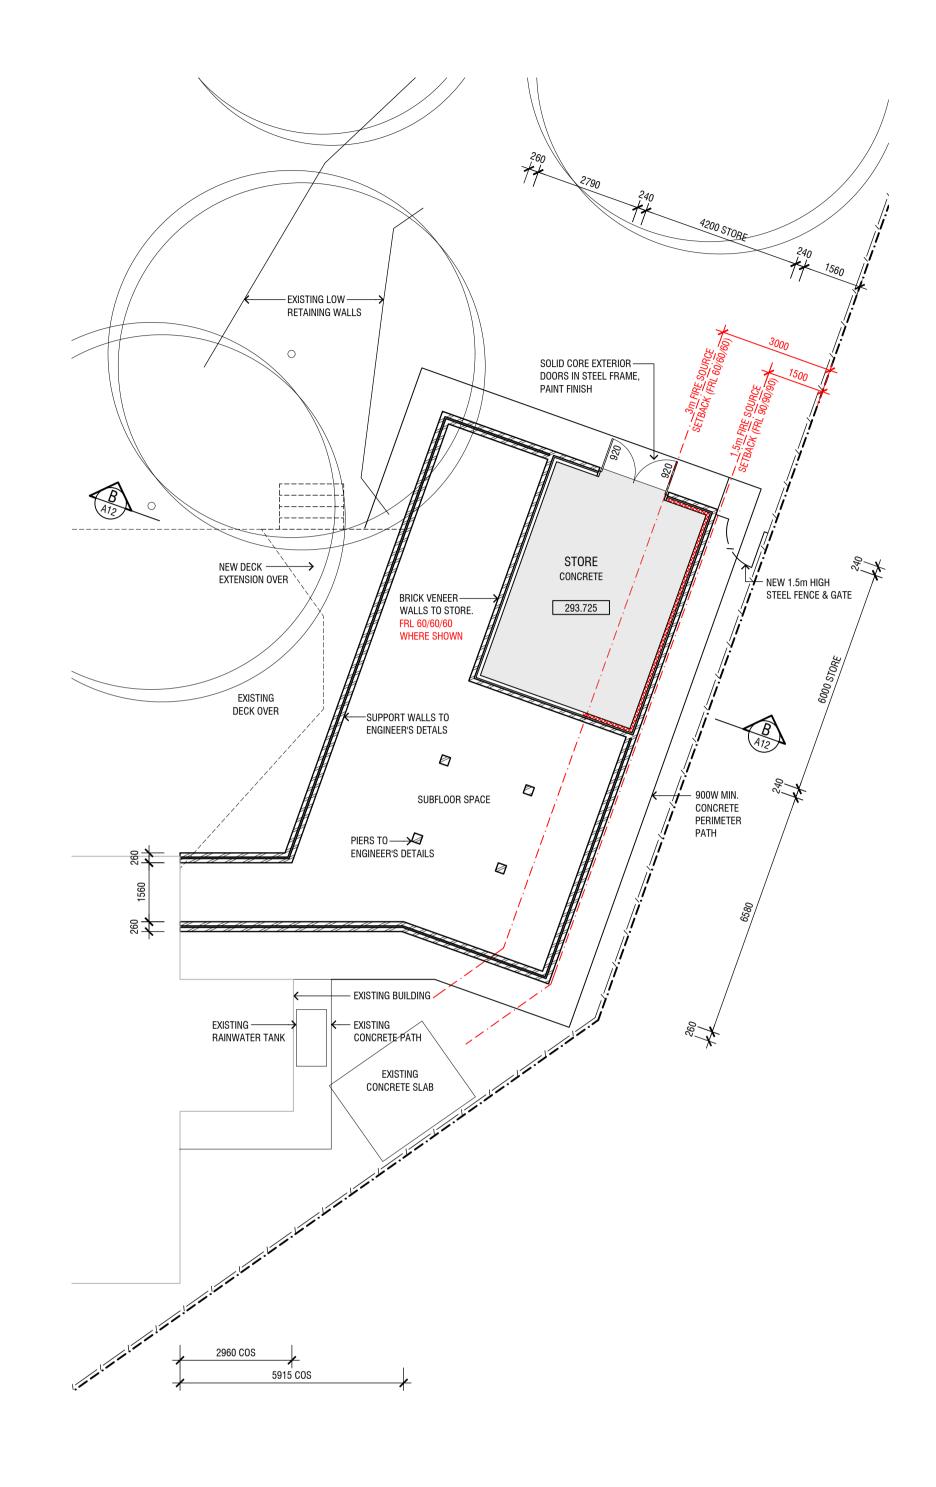


2000 x 1000 DIGITAL SIGNAGE ZONE REFER SEPERATE SIGNAGE DOCUMENTS ASSOCIATED WITH THIS DEVELOPMENT FOR SIGNAGE STRUCTURE & ENGINEERING DETAILS

- SIGN DETAIL - FRONT ELEVATION - SCALE 1:50

- FLOOR PLAN - LOWER LEVEL - SCALE 1:100

SYMBOLS LEGEND ABBREVIATIONS LEGEND COS CHECK ON SITE RED CROSS HATCH INDICATES EXTENT OF NEW FRL 60/60/60 WALLS

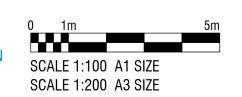

7	ISSUED FOR DA	31/10/2024
6	PROGRESS ISSUE	28/10/2024
5	PROGRESS ISSUE	23/11/2023
4	PROGRESS ISSUE	17/11//2023
3	PROGRESS ISSUE	8/11/2023
2	ISSUED FOR COMMENT	15/08/2023
1	ISSUED FOR COMMENT	19/04/2023





Shop 30 Kooringal Mall Lake Albert Road PO Box 8834 Wagga Wagga, NSW, 2650 p: 02 6922 6388 A C C R E D I T E D BUILDING DESIGNER e: icono@icono.com.au w: www.icono.com.au

PROPOSED ALTERATIONS AND ADDTIONS TUMUT COMMUNITY PRESCHOOL LOT 1, DP 828879 50 HOWICK STREET, TUMUT


Client	
TUMUT	COMMUNITY PRESCHOOL
Chast Tills	


FLOOR PLAN - LOWER LEVEL


Project No. 22-37	Designed	ICONO	Sheet No.
Scale AS SHOWN AT A1	Drawn	ICONO	Issue / Ame


A05 Issue / Amendment No. 7


THIS DRAWING IS TO BE READ IN CONJUNCTION WITH ALL DRAWINGS AND SPECIFICATIONS RELATING TO THIS PROJECT. REFER SHEET A01 FOR BUILDING NOTES AND COMPLIANCE NOTES. -----CLASSROOM OFFICE COVERED OUTDOOR COVERED AREA OUTDOOR AREA RECEPTION UNISEX ACC. WC CONNECT NEW STORMWATER
LINE TO EXISTING ST FROM RELOCATED AS REQUIRED FIRST FLOOR CHILDREN'S STAFF ROOM WC AMB. WC LDRY GIRRA GIRRA GINDHAY ROOM - INDICATIVE LOCATION OF EXISTING SEWER LINE. LOCATION TO BE CONFIRMED ON SITE KITCHEN _CHILDREN'S WC — GINDHAY MALAYARR ROOM INDICATIVE LOCATION OF —— GIRRA GIRRA ROOM EXISTING STORMWATER LINE. LOCATION TO BE CONFIRMED INDICATIVE LOCATION OF -----EXISTING SEWER LINE. LOCATION TO BE LINE TO EXISTING CONFIRMED ON SITE INDICATIVE LOCATION OF EXISTING CONNECT NEW SEWER — STORMWATER LINE. LOCATION TO LINE TO EXISTING BE CONFIRMED ON SITE - CONNECT NEW STORMWATER LINE TO EXISTING STAFF / STORE ROOM ISSUED FOR DA 31/10/2024 PROGRESS ISSUE 28/10/2024 К-----Community
Preschool - PLUMBING PLAN - GROUND LEVEL - SCALE 1:100 Shop 30 Kooringal Mall Lake Albert Road PO Box 8834 Wagga Wagga, NSW, 2650 SEWER & STORMWATER NOTE PLUMBING LEGEND **p:** 02 6922 6388 PLUMBING LAYOUT SHOWN IS INDICATIVE ONLY. SEWER & — – – STORMWATER PIPE - EXISTING A C C R E D I T E D BUILDING DESIGNER e: icono@icono.com.au STORMWATER DESIGN, NUMBER OF DOWNPIPES, LOCATIONS w: www.icono.com.au ----- SEWER PIPE - EXISTING WC TOILET (WATER CLOSET) & CONNECTIONS TO PLUMBING CONTRACTORS DETAIL. SK SINK CONTRACTOR TO LOCATE ALL UNDERGROUND SERIVCES, --- STORMWATER PIPE - NEW SK-C SINK - CLEANER'S BOUNDARY RISERS & MAINS SPURS PRIOR TO T LAUNDRY TUB COMMENCEMENT OF WORK. ----- SEWER PIPE - NEW PROPOSED ALTERATIONS AND ADDTIONS CONNECT NEW SEWER & STORMWATER PIPE SYSTEM TO EXISTING COUNCIL MAINS SYSTEM IN ACCORDANCE WITH HB HAND BASIN TUMUT COMMUNITY PRESCHOOL FW FLOOR WASTE NCC AND PLUMBING CODE REQUIREMENTS. ROP ROD OUT POINT LOT 1, DP 828879 ST SEWER STACK 50 HOWICK STREET, TUMUT DP DOWNPIPE - NEW DP-E DOWNPIPE - EXISTING TUMUT COMMUNITY PRESCHOOL GP GRATED PIT - NEW PLUMBING PLAN - GROUND LEVEL 22-37 ICONO SCALE 1:100 A1 SIZE A06 SCALE 1:200 A3 SIZE AS SHOWN AT A1 ICONO Issue / Amendment No.

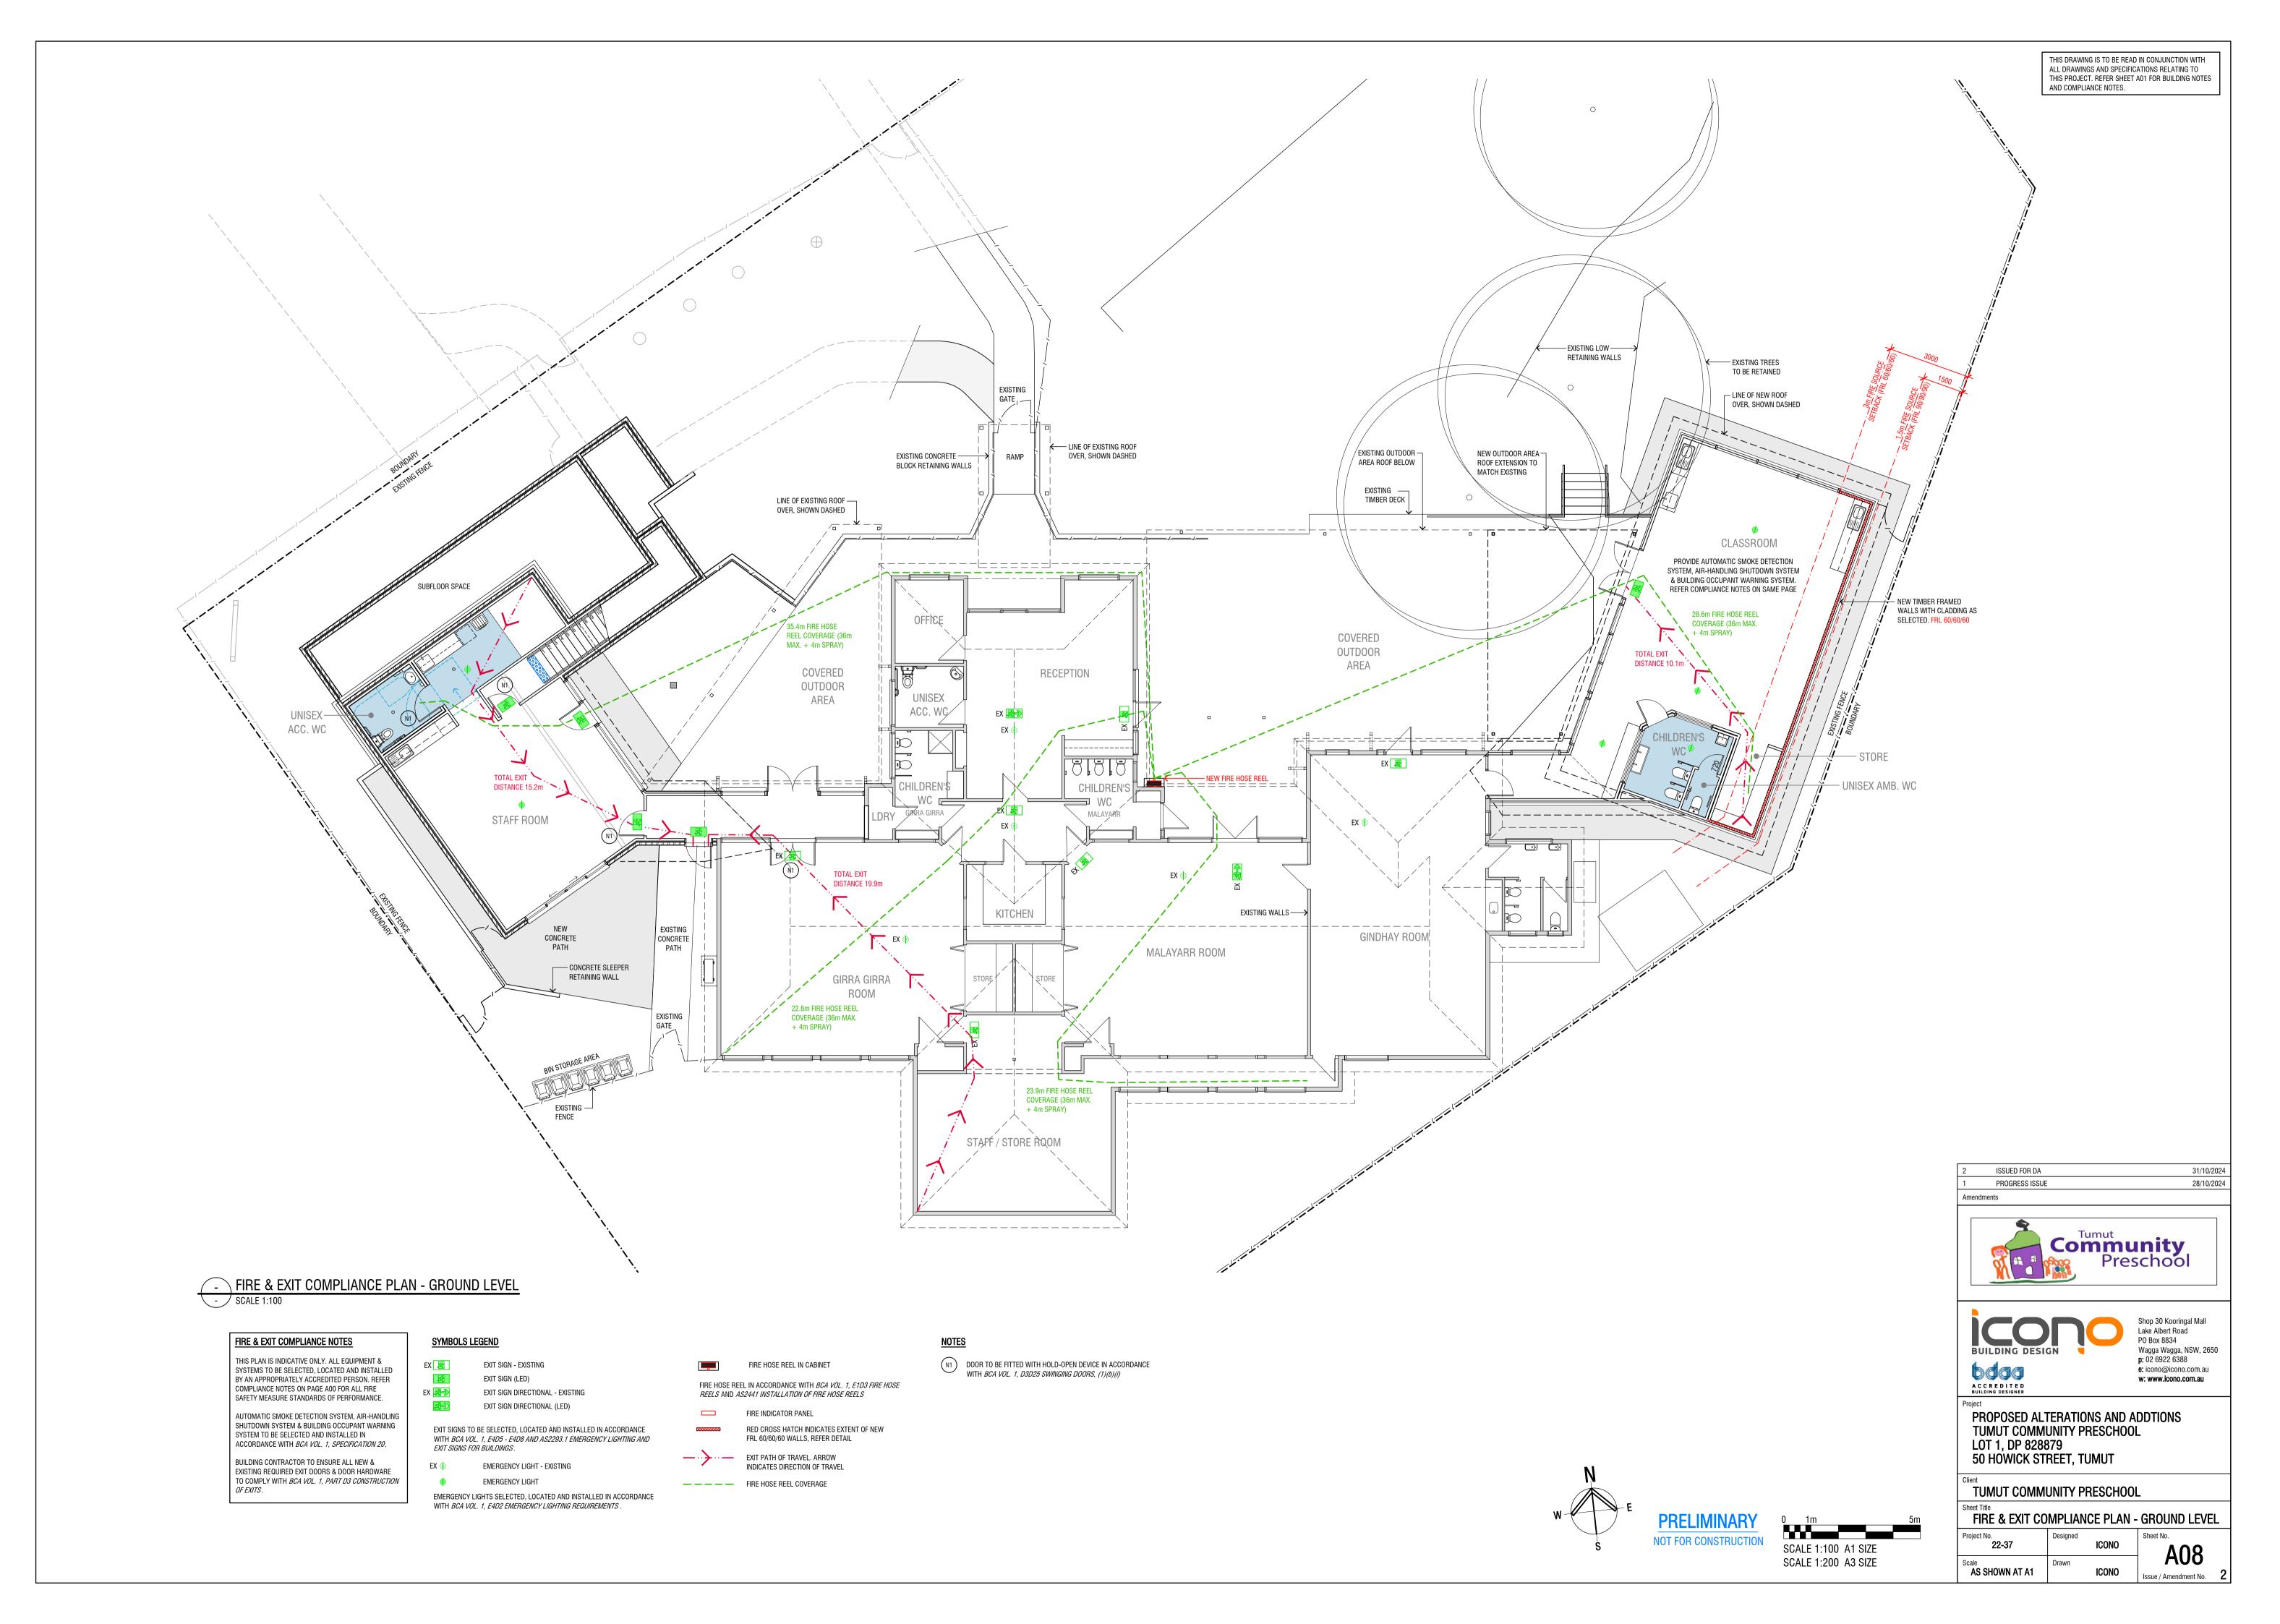


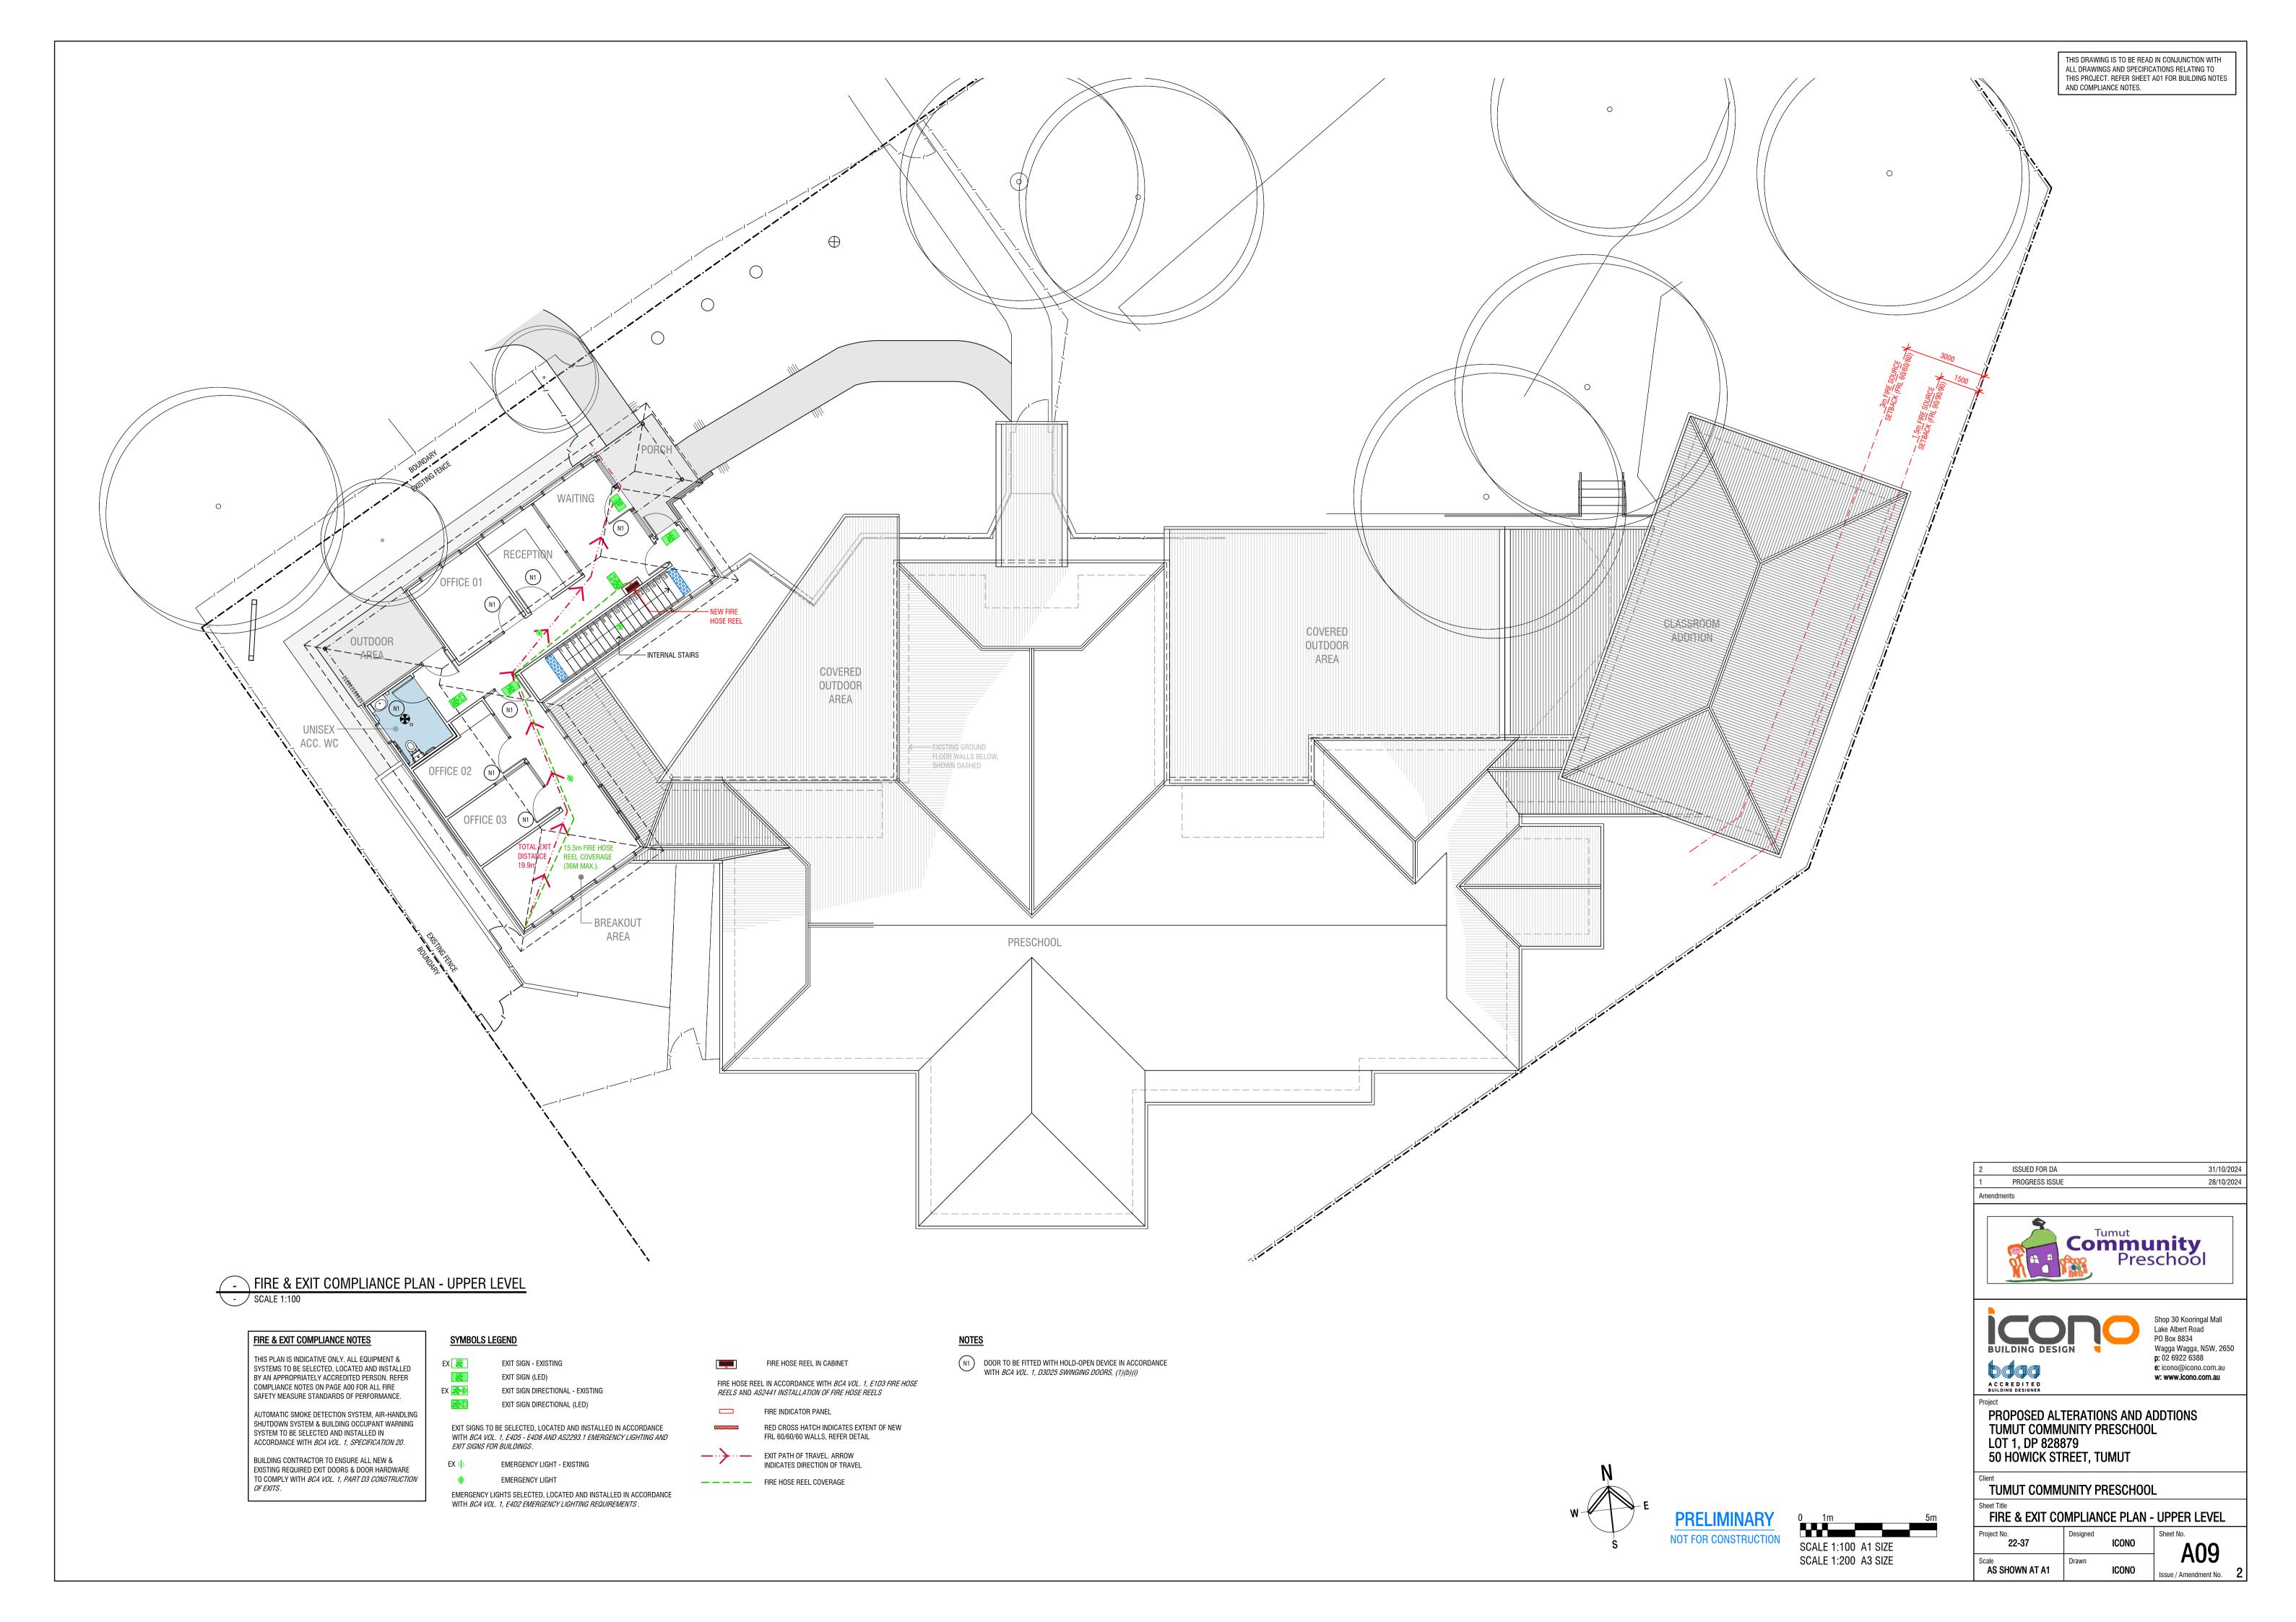


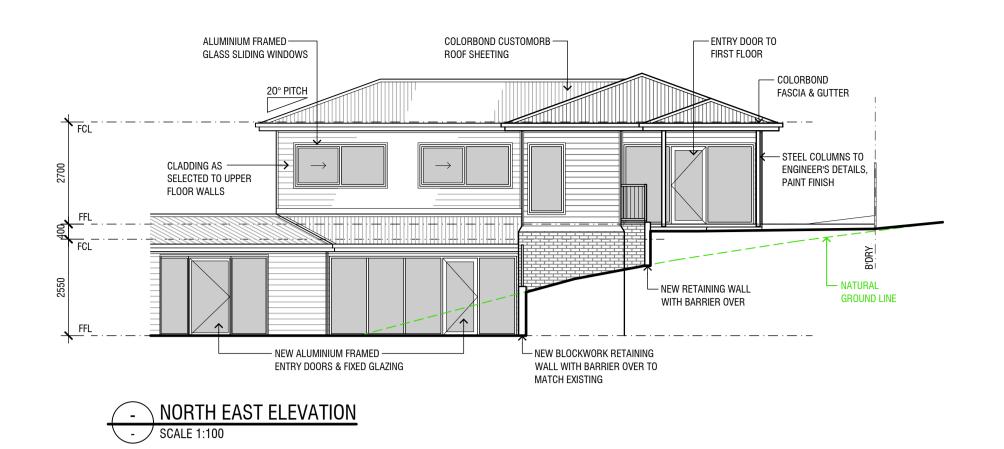

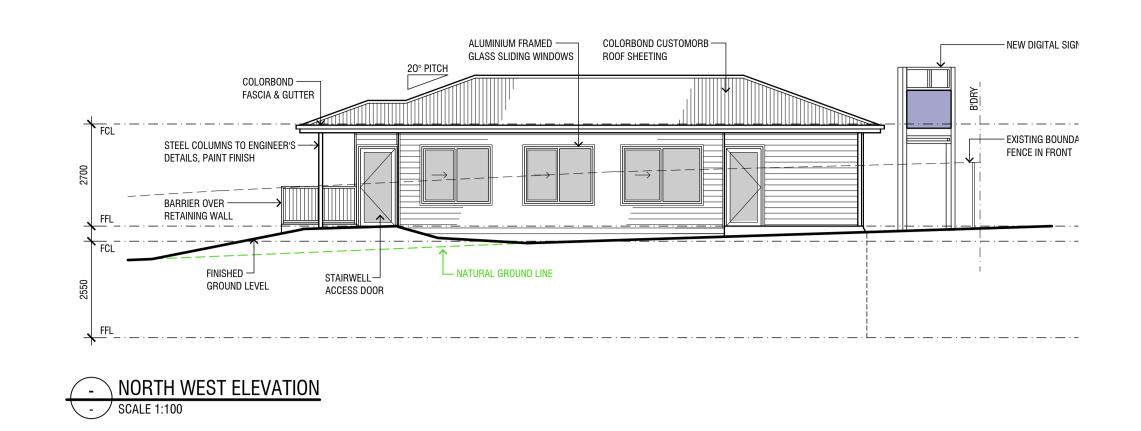

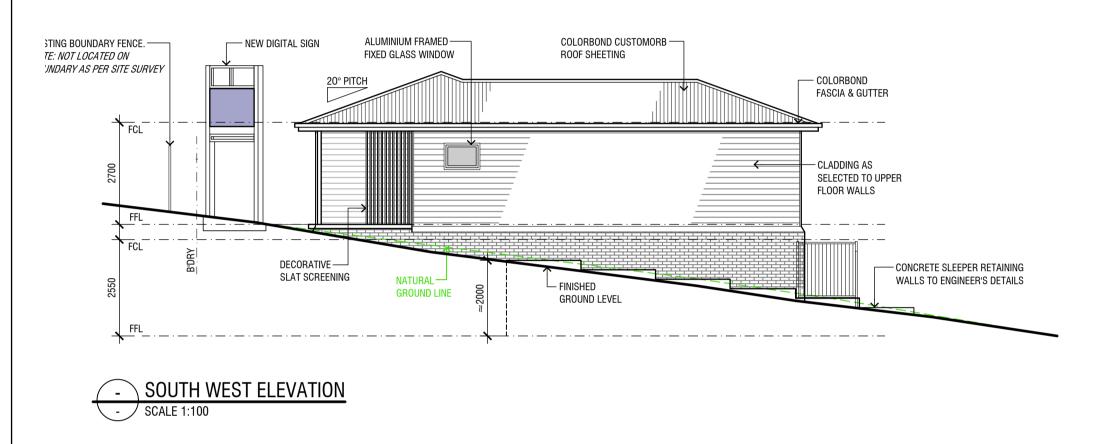

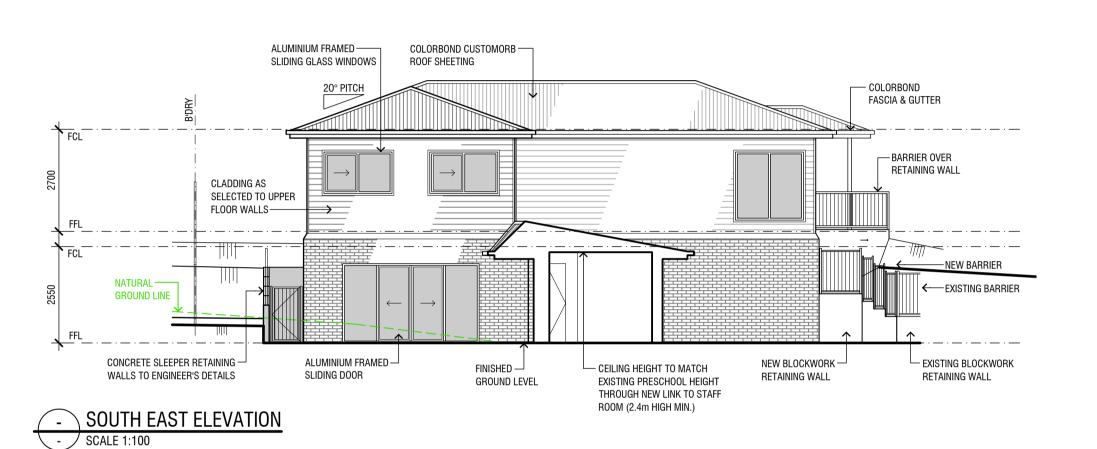

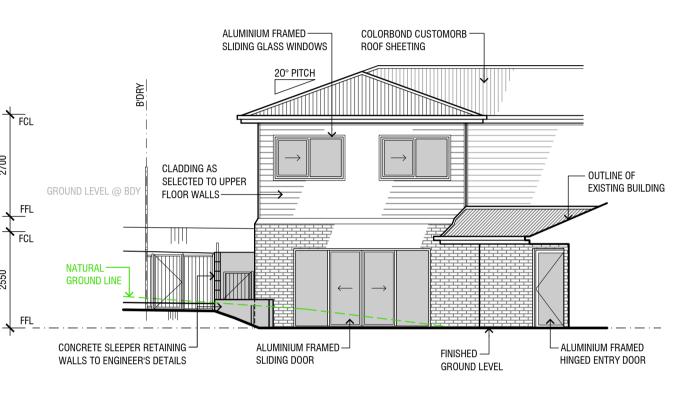

- SOUTH EAST PARTIAL ELEVATION
- SCALE 1:100

SCALE 1:50 A1 SIZE


SCALE 1:100 A3 SIZE


SCALE 1:100 A1 SIZE

SCALE 1:200 A3 SIZE

PRELIMINARY

NOT FOR CONSTRUCTION

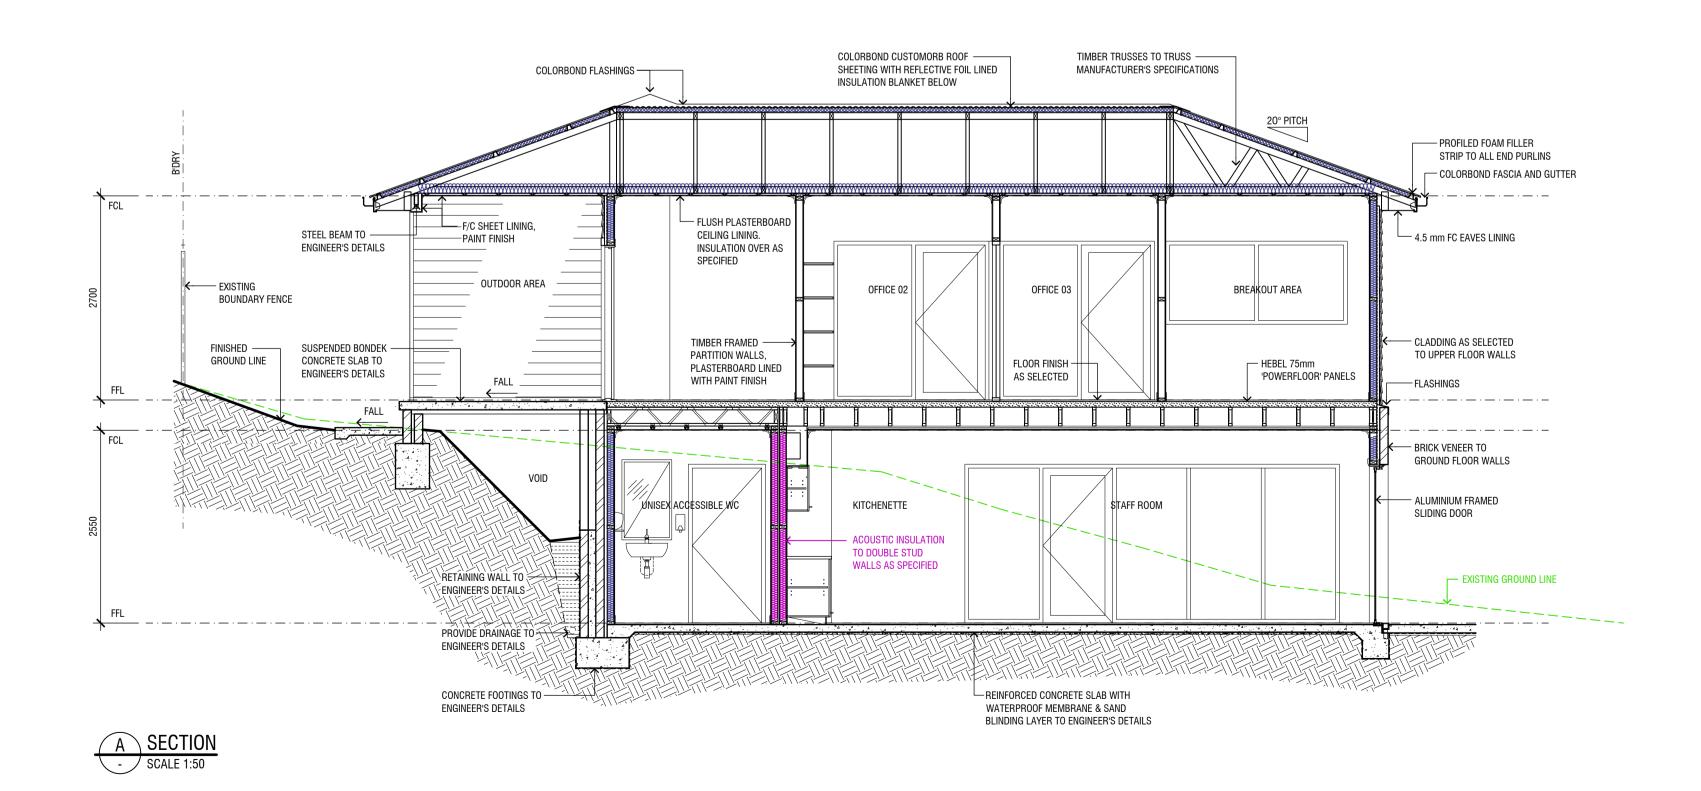

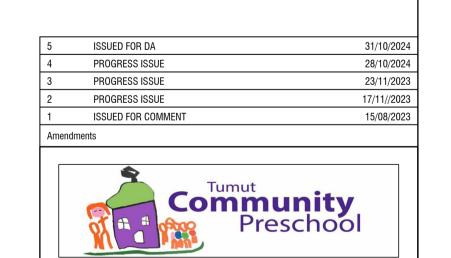



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PROPOSED ALTERATIONS AND ADDTIONS
TUMUT COMMUNITY PRESCHOOL

LOT 1, DP 828879 50 HOWICK STREET, TUMUT

Client
TUMUT COMMUNITY PRESCHOOL

Sheet Title

ELEVATIONS & SECTION - OFFICE


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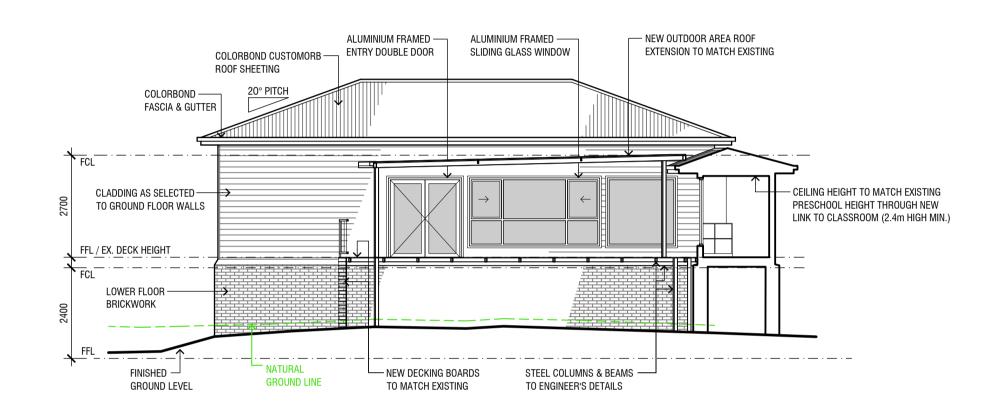
22-37

Designed


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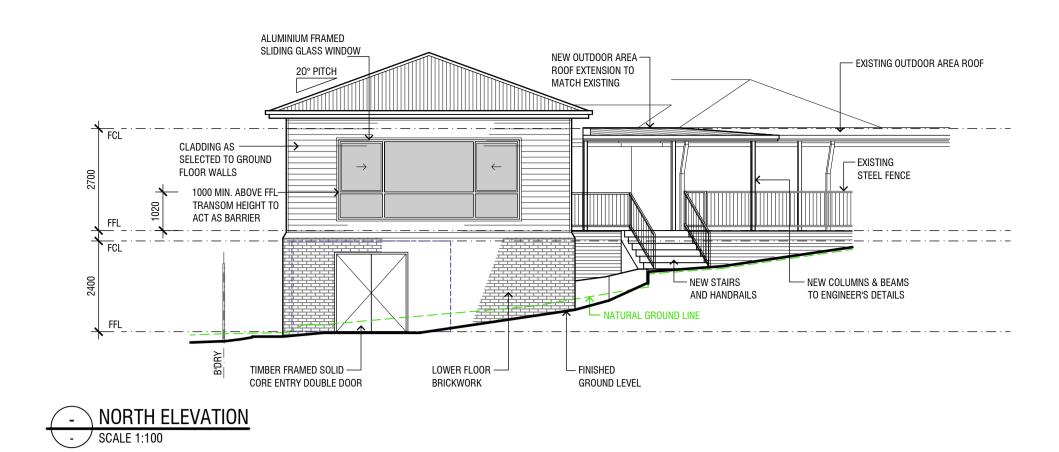
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22-37
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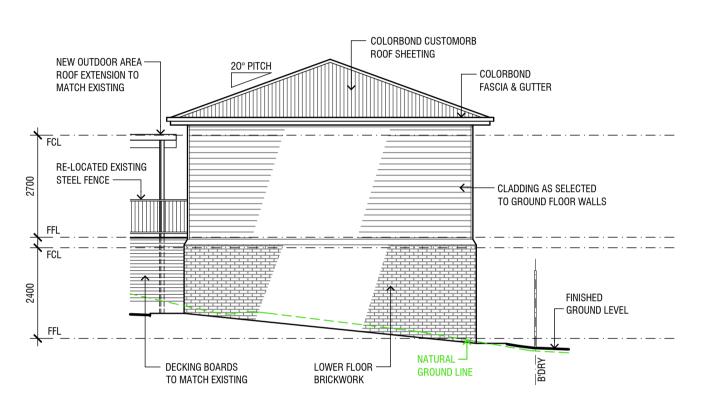





- WEST ELEVATION

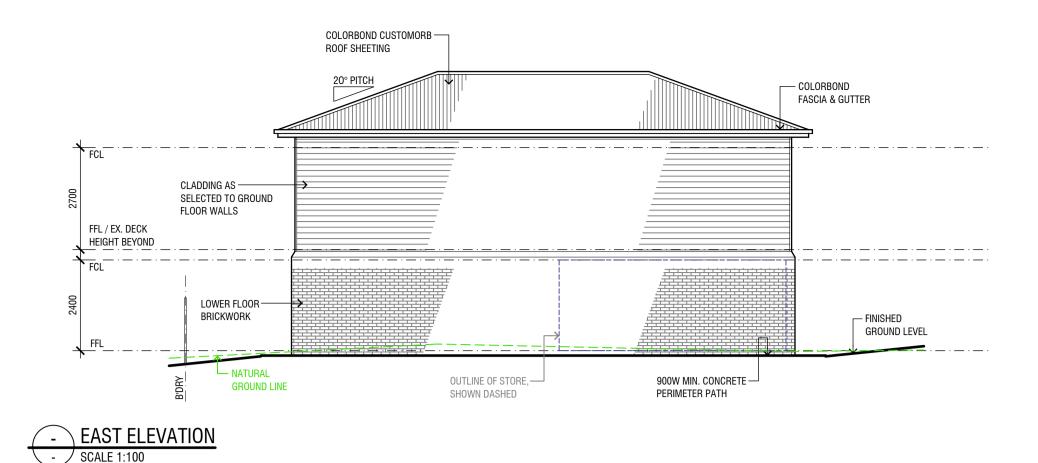




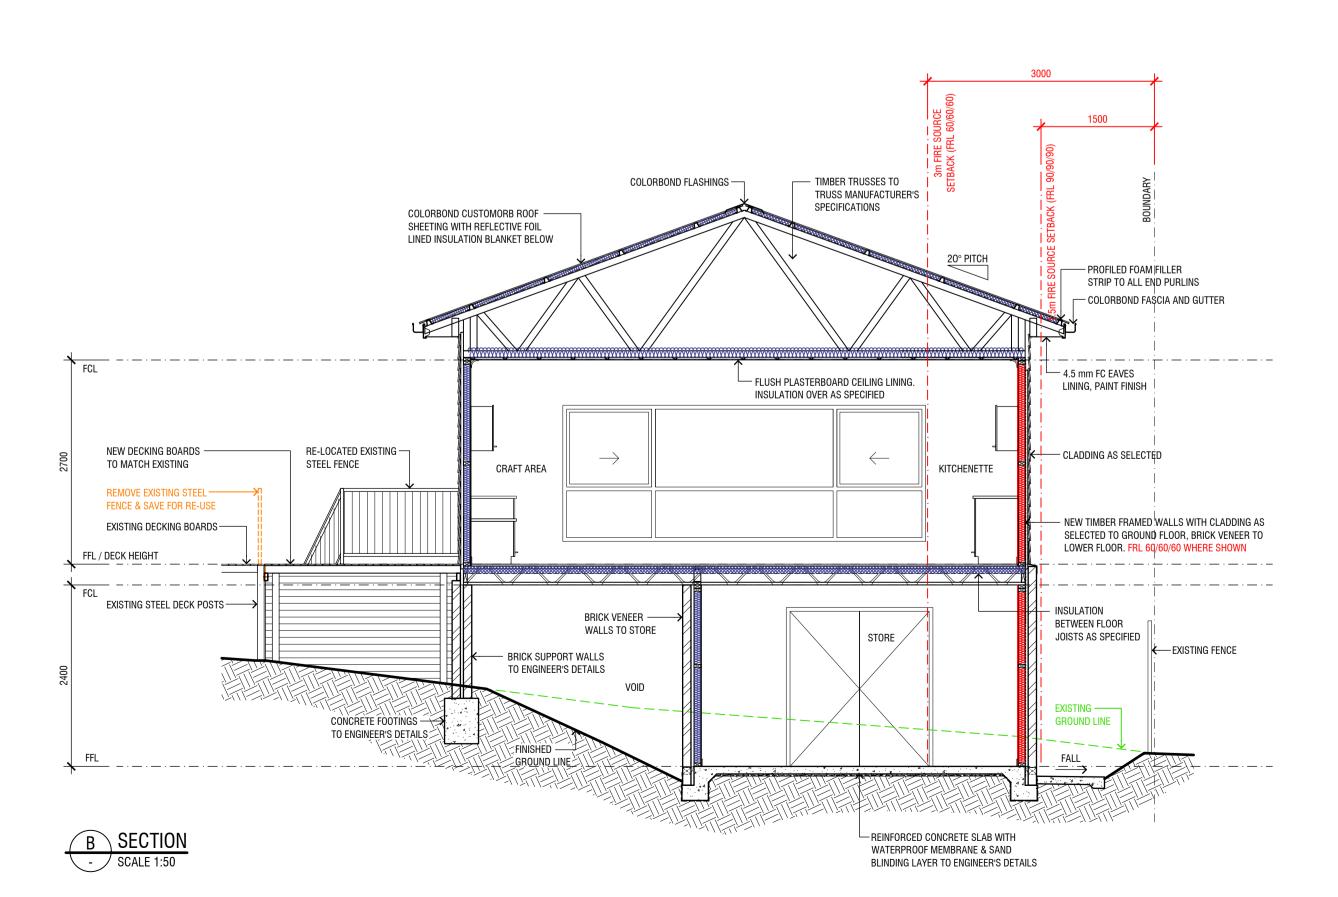

- SOUTH ELEVATION

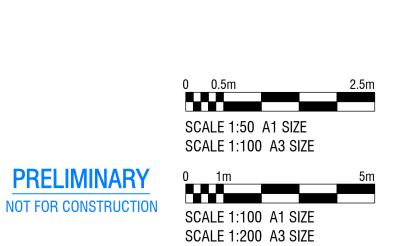

PRELIMINARY

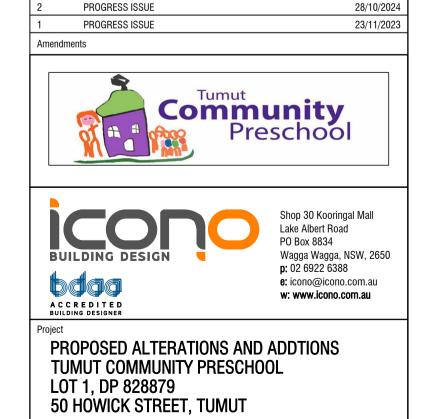

31/10/2024

A12

TUMUT COMMUNITY PRESCHOOL **ELEVATIONS & SECTION - CLASSROOM**

ISSUED FOR DA

22-37 AS SHOWN AT A1 ICONO